PROPOSED BUILDING BETTER IN BELIZE, ECO- COMMUNITY

IO.5 MLS MOLLEJON ROAD, BENQUE VIEJO DEL CARMEN TOWN, CAYO DISTRICT, BELIZE C.A.

A00 COVER

ARCHITECTURAL DRAWINGS

- AOI APPROX. SITE LOCATION & SITE PLAN
- AO2 ARCHITECTURAL & DIMENSIONED FLOOR PLAN
- A03 BUILDING ELEVATIONS 1,2 \$3
- A04 BUILDING ELEVATION 4 & SECTION 'A-A'
- A05 BUILDING SECTION 'B-B', DOOR & WINDOW SCHEDULE
- A06 ROOF PLAN & ROOF DETAILS


STRUCTURAL DRAWINGS

- SOI STRUCTURAL GENERAL NOTES & DETAILS
- 502 FOUNDATION, WATER TANK COLUMN & FLOOR REINF. PLAN
- 503 WATER TANK BEAM & GROUND FLOOR COLUMN & REINF. PLAN
- 504 FOUNDATION, BEAM & COLUMN DETAILS
- SOS WATER TANK SECTIONS
- 506 FOOTING & COLUMN CONNECTION SECTIONS
- 507 WALL, SILL, LINTEL & BEAM DETAILS

MECHANICAL DRAWINGS

- MOI ELECTRICAL LEGEND & NOTES
- MOZ ELECTRICAL LIGHTING & POWER PLAN
- MO3 PLUMBING LEGEND & NOTES
- MO4 PLUMBING SUPPLY & DRAINAGE PLAN
- MOS SEPTIC TANK PETAILS
- MOG SOAK-AWAY DETAILS



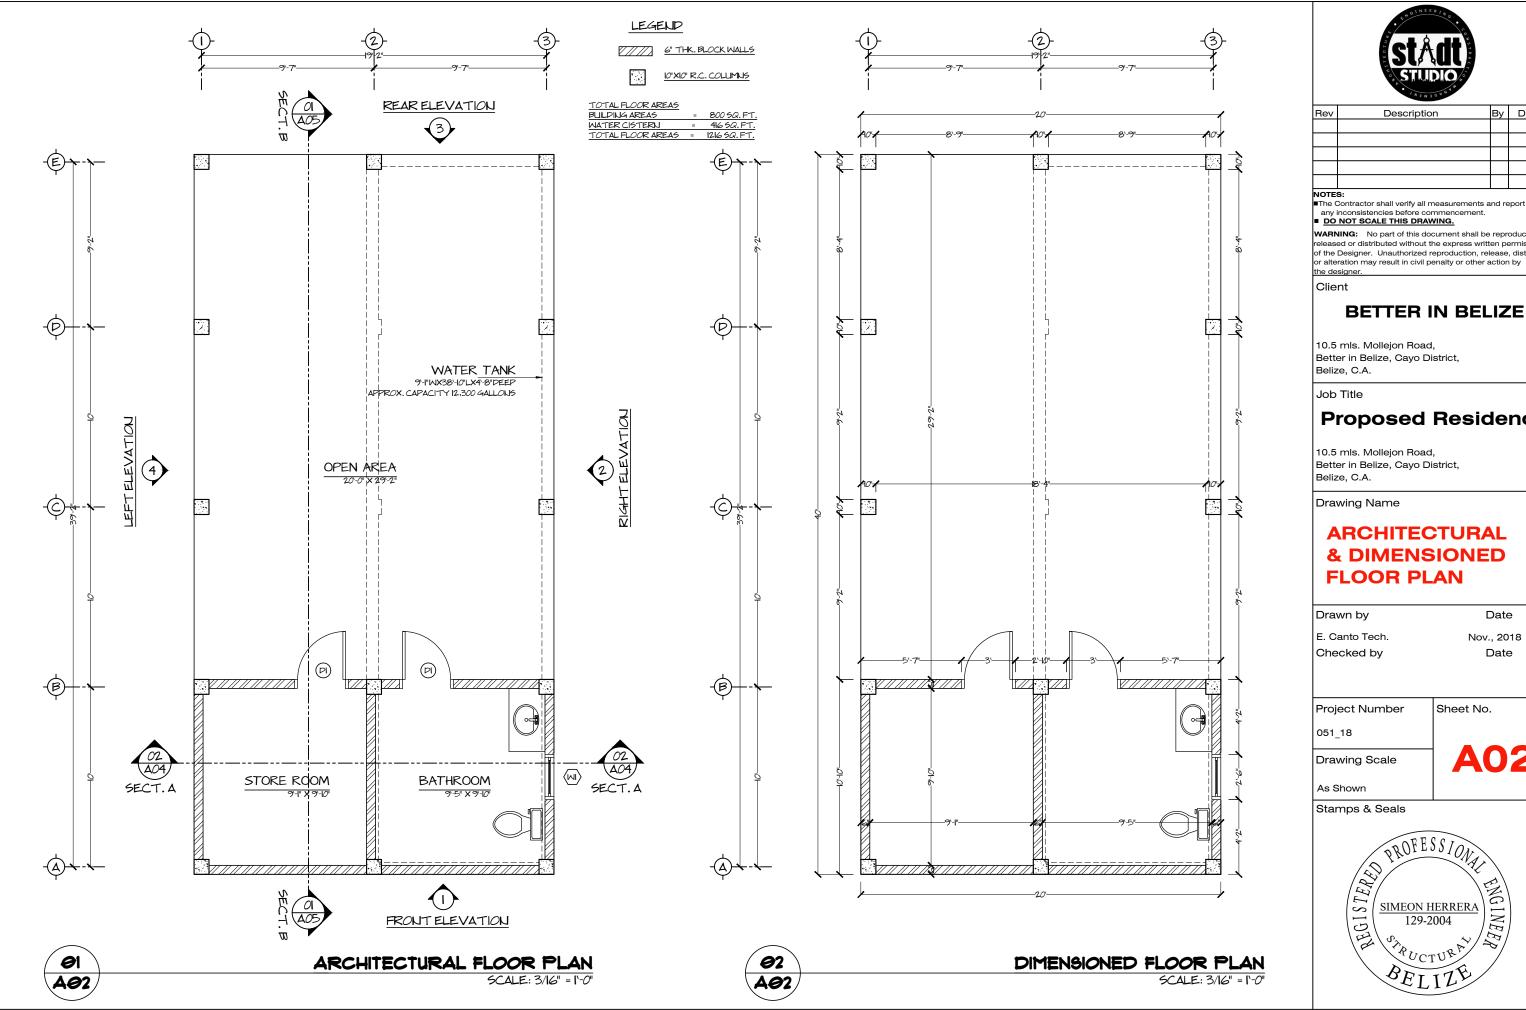



Rev	Description	Ву	Date

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BETTER IN BELIZE

Better in Belize, Cayo District,

Proposed Residence


Better in Belize, Cayo District,

& DIMENSIONED **FLOOR PLAN**

Date Nov., 2018 Date

Sheet No.



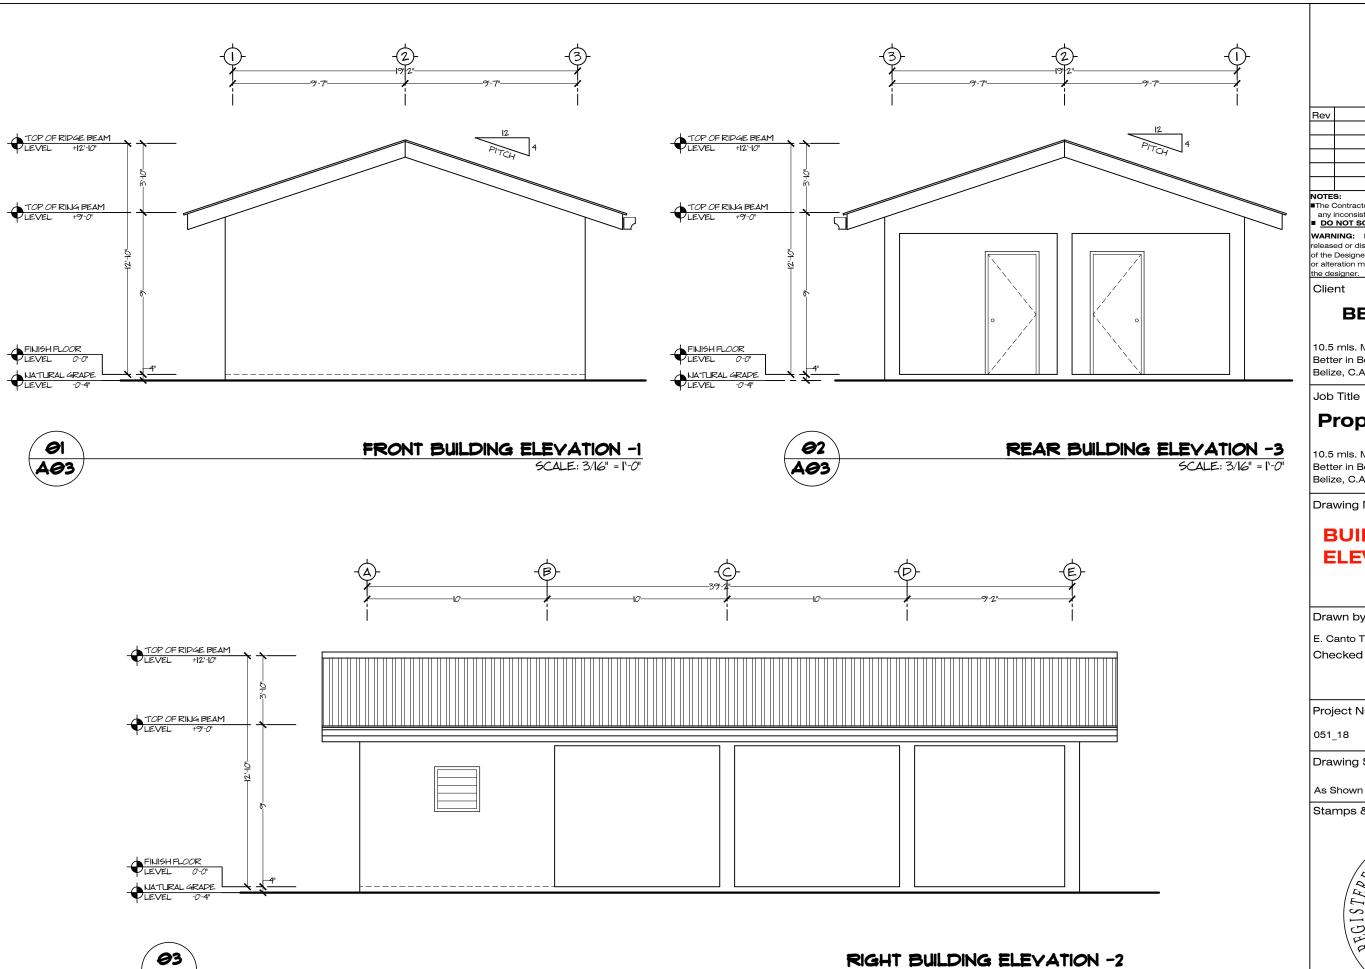

A03



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Job Title

Proposed Residence

10.5 mls. Mollejon Road, Better in Belize, Cayo District, Belize, C.A.

Drawing Name

BUILDING ELEVATIONS

Drawn by Date E. Canto Tech. Nov., 2018 Checked by Date

Project Number

Sheet No.


051_18

SCALE: 3/16" = 1'-0"

Drawing Scale

A03



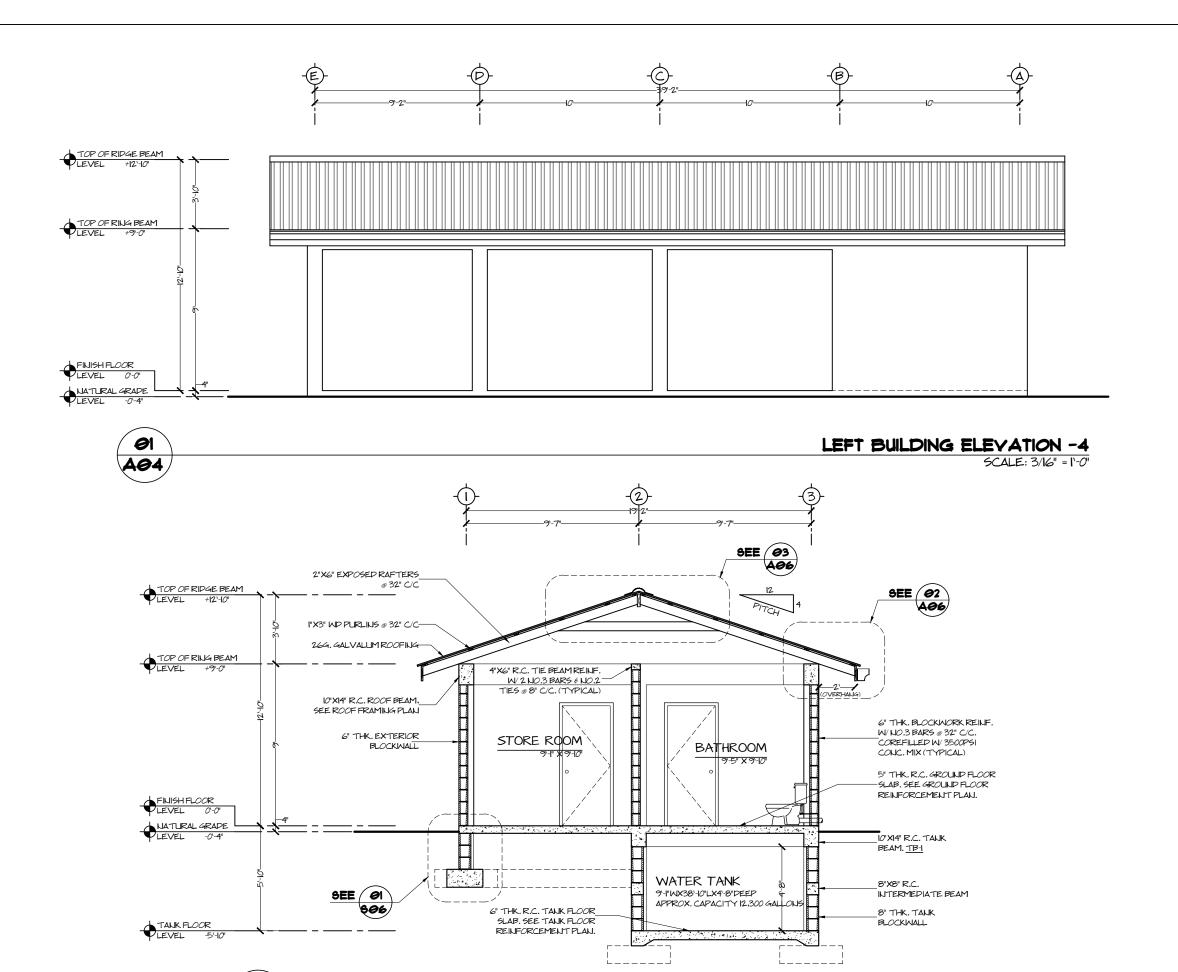

A04

BUILDING SECTION - 'A-A'

SCALE: 3/16" = 1'-0"



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Proposed Residence

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Drawing Name

BUILDING **ELEVATION & SECTION 'A-A'**

Drawn by Date E. Canto Tech. Nov., 2018 Checked by Date

Project Number

Sheet No.


051_18


As Shown

Stamps & Seals

Drawing Scale



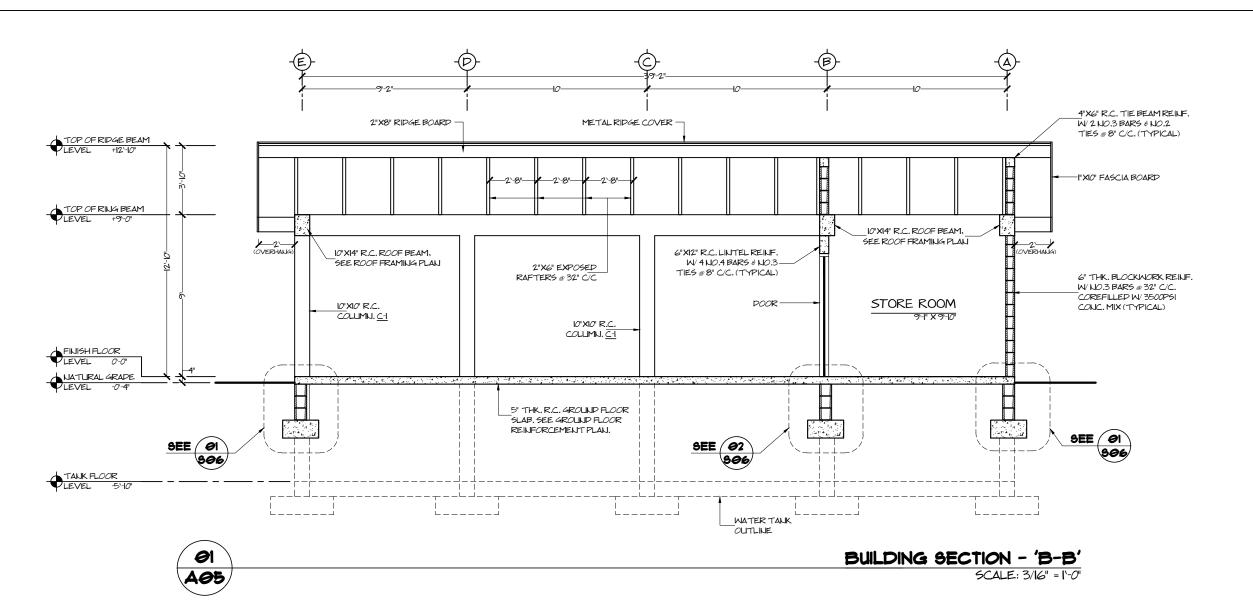

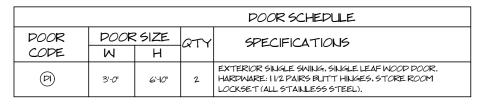

	l	NINDON	1 SCHE	EPULE
WIND.	MIND	. SIZE	275	SPECIFICATIONS
COPE	M	H	<u> </u>	
(MI)	2'-6"	2`-6"	ı	ALLMINUM LOUVERED WINDOWS, WHITE ALLMINUM FRAME, MECHANICALLY OPERATED.

GENERAL POOR & WINDOW NOTES:
CONTRACTOR SHALL VERIFY ALL POOR WINDOW OPENINGS PRIOR TO PURCHASE MANUFACTURE POORS WINDOWS.
ALL DOOR SIZES SPECIFIED INCLUDES POOR PANEL WITH FRAME.

DOOR PANELS: LINLESS OTHERWISE STATED, ALL WOODEN DOORS SHALL BE DARK HARDWOOD, SAND, SEALED AND VARNISHED.

DOOR FRAMES: LINLESS OTHERWISE STATED, ALL DOOR FRAMES SHALL BE 13/4" X WALL THICKNESS DRESSED HARDWOOD FINISHED TO MATCH DOOR PANELS AND SECURE TO WALL WITH 1/2" DIA. STAINLESS STEEL ANCHOR BOLTS W/ WASHERS (3 EACH ON VERTICAL FRAMES \$ 2 ON HORIZONTAL FRAME).



0

(2)

 $\langle M \rangle$

DOOR \$ WINDOW SCHEDULE



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Drawing Name

BUILDING SECTION 'B-B', DOOR & **WINDOW SCHEDULE**

Drawn by Date E. Canto Tech. Nov., 2018 Checked by Date


Project Number


Sheet No.

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Drawing Scale


As Shown



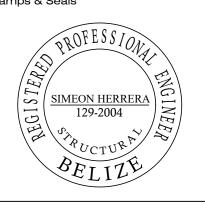


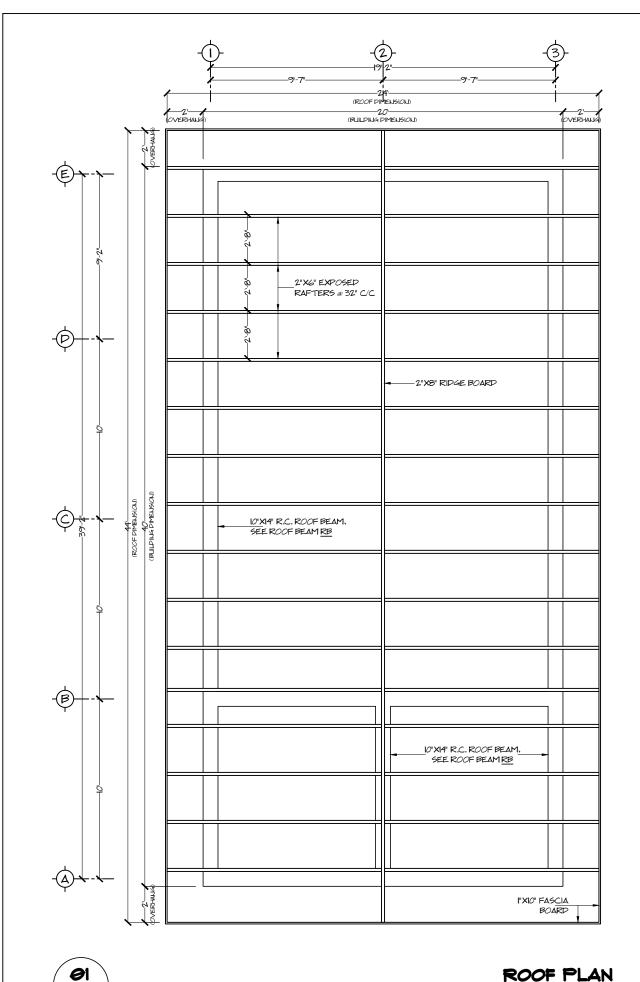A06

SCALE: 3/16" = 1'-0"

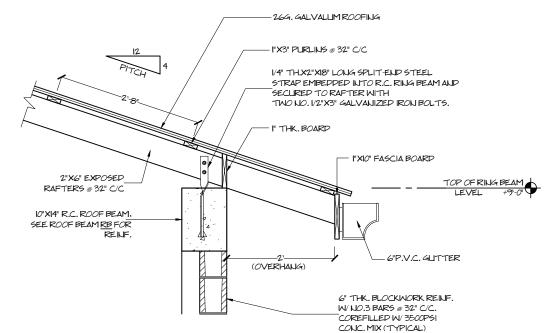



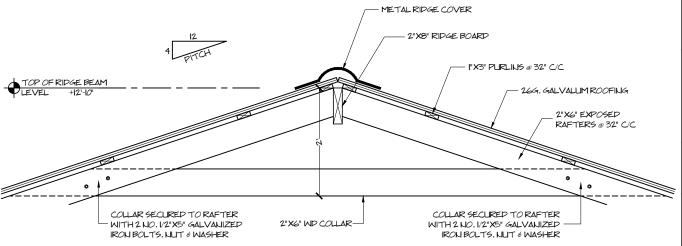





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Drawing Name

ROOF PLAN & ROOF DETAILS

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Sheet No.


051_18

Drawing Scale

As Shown



TYPICAL SPLICE SCHEPULE							
i OL		RE	INFORCI	ING BAR	SPLICE L	ENGTH	
TENSION SPLICES	-	BAR SIZE GRADE 60	*8	*7	*6	* 5	*4
	8	TOP 1	3'-9"	3'-2"	2'-9"	2'-4"	1'-10"
	3000	BOTTOM 2	2'-11"	2'5"	2'-1"	1'-9"	1'5"
CLA55 A	8	TOP I	3'-3"	2'-9"	2'-4"	2'-3"	l'-7"
D A	4000	BOTTOM 2	2'-6"	2'-3"	1'-10"	1'-9"	1'-3"
	8	TOP I	2'-11"	2'5"	2'-3"	2'-0"	1'5"
	5000	BOTTOM 2	2'-3"	1-11"	1'-8"	1-6"	1'-1"
	8	TOP I	4'-1"	4'-1"	3'-6"	2'-11"	2'-4"
	3000	BOTTOM 2	3'-9"	3'-2"	2'-9"	2'-4"	l'-l <i>0</i> "
CLASSB	8	TOP I	4'-3"	3'-7"	3'-1"	2'-6"	2`-I"
	4000	BOTTOM 2	3'-3"	2'-9"	2'-4"	2'-0"	ľ-7"
	8	TOP I	3'-10"	2'-1"	2'-9"	2'-3"	r-1 <i>0</i> "
	2000	BOTTOM 2	2'-11"	2'-5"	2'-1"	1'-9"	1'-5"

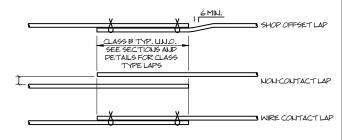

CLASS A MAY BE USED WHERE LAPS ARE WELL STAGGERED \$
NO MORE THAN 50% OF THE BARS ARE SPLICED AT ONE LOCATION.

- FOOTNOTES: I, TOP BAR: HORIZONTAL REINFORCING WITH MORE THAN 12" OF CONCRETE BELOW BAR.
- 2. BOTTOM BAR: ALL VERTICAL, ALL HORIZONTAL WALL REINFORCING, AND
- HORIZONTAL REINFORCING INITH LESS THAN 12" OF COLICRETE BELOW BAR.

 3. ALL LAP SPLICES SHALL BE CLASS "B" SPLICE EXCEPT THAT CLASS "A"

 SPLICES MAY BE LISED WHEN ONE HALF OR LESS OF THE TOTAL

 REINFORCEMENT IS SPLICED WITHIN THE REQUIRED LAP LENGTH.
- 4. MINIMUM CLEAR SPACES OF BARS SHALL BE NOT LESS THAN 3 BAR DIAMETER.

REINE CONCLINITED SCHEDULE

LINTEL SCHEPULE						
THK.	SPAN	5	T RE	INFORCEME B	ENT B	
6" ∉ 8"	4 ° 0'	6" 8"	/	2-1/2"	3/8"	8" /
6" \$8"	4-0 8\0'	6" 8"	2-3/8"	2-3/8"	3/8"	8" /

MINIMUM I" CVR.

SØ1

STRUCTURAL GENERAL NOTES \$ DETAILS

DESIGN LOADS

I.FLOOR LIVE LOAD 50 PSF (LINFACTORED) ROOF LIVE LOAD 20 PSF (LINFACTORED) WIND LOADS _150 .(ASCE-02)

BUILDING CODES:

INTERNATIONAL BUILDING CODE 2003 (IBC-2003) ASCE-2002

REINFORCEMENT

- I ALL 3/8" DIAMETER REINFORCEMENT STEEL SHALL CONFORM TO A.S.T.M. A-6/5. GRADE 60. ALL LARGER DIAMETER REINFORCEMENT SHALL BE DEFORMED AND CONFORM TO A.S.T.M. A-615, GRADE 60.
- 2. ALL REINFORCING STEEL SHALL BE TIED AND SUPPORTED IN SUCH A MANNER AS TO ENSURE THAT THEY MAINTAIN THERE PROPER COVERAGE DURING THE PLACING OF CONCRETE.
- 3. MINIMUM COMPRESSION LAP SPLICES SHALL BE 30X BAR PIAMETER. LINLESS NOTED OTHERWISE ON PRAWINGS, MINIMUM POWEL EMBEDMENT SHALL BE 22X BAR PIAMETER, UNLESS NOTED OTHERWISE.
- 4. ALL REINFORCEMENT, AT THE TIME OF PLACEMENT OF CONCRETE SHALL BE FREE OF MUID, OIL, OR OTHER MATERIALS WHICH MAY AFFECT OR REDUCE BONDING OF CONCRETE.
- 5. MINIMUM COVERAGE OF CONCRETE SHALL BE AS FOLLOWS:


CONCRETE DEPOSITED AGA	AINST THE GROUND3.
CONCRETE COLLIMNS	
CONCRETE BEAMS	1.5 .

LINLESS NOTED OTHERWISE ON DRAWINGS.

CONCRETE

I. ALL CEMENT SHALL CONFIRM TO A.S.T.M. C-150, TYPE IP. LINLESS NOTED OTHERWISE.

2. WATER USED IN MIXING CONCRETE SHALL BE CLEAN, POTABLE AND FREE FROM INJUROUS AMOUNT OF OILS, ACIDS, ALKALIS, SALTS, ORGANIC MATERIAL AND OTHER SUBSTANCES DELETERIOUS TO CONCRETE OR REINFORCEMENT.

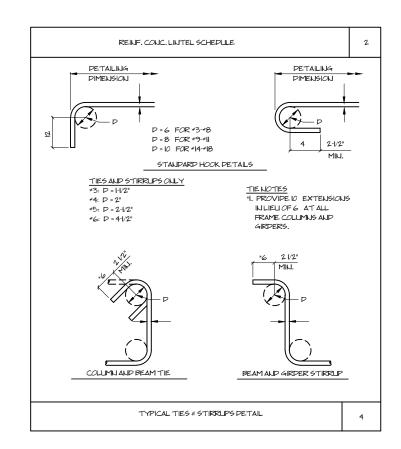

3. AGGREGATES FOR NORMAL WEIGHT CONCRETE SHALL MEET THE REQUIREMENTS FOR A.S.T.M. C-3 UNLESS OTHERWISE SPECIFIED. THE NOMINAL SIZE OF AGGREGATES USED SHALL NOT EXCEED 1/5 OF THE NARROWEST DIMENSION BETWEEN SIDES OF FORMS, 1/3 THE DEPTH OF SLABS OR 3/4 THE MINIMUM CLEAR SPACING BETWEEN INDIVIDUAL REINFORCING BARS WITHIN MEMBERS.

4. THE SPECIFIED COMPRESSIVE STRENGTH OF CONCRETE ', SHALL BE AS FOLLOWS:

3500 PSI CONCRETE SLAB ----BEAMS & GIRDERS --3500 PSI COLUMNS ----3500 PSI FOUNDATION -----3000 PSI

- '-SPECIFIED 28 DAYS COMPRESSIVE STRENGTH OF CONCRETE, PSI.
- 5. ALL CONCRETE SHALL CONFORM TO THE REQUIREMENTS OF THE AMERICAN CONCRETE INSTITUTE 318-02

CURING OF CONCRETE

I. BEGINNING IMMEDIATELY AFTER PLACEMENT, CONCRETE SHALL BE PROTECTED FROM PREMATURE DRYING, EXCESSIVELY HOT OR COLD TEMPRETURES, FOR A MINIMUM OF 7 DAYS. THIS MAY BE ACHIEVED BY ANY OF THE FOLLOWING METHODS:

) BY CONTINUOUS SPRINKLING

) APPLICATION OF ABSORPTIVE MATS OF FABRIC KEPT CONTINUOUSLY WET.

) APPLICATION OF SAND KEPT CONTINUOUSLY WET.

MASONRY

- I. FOLINDATION WALLS SHALL BE 8" THK. BLK. WITH VERTICAL REINFORCEMENT 3/8" PIA. BARS AT 32" O.C. GROUT SOLIP ALL CELLS (SEE KEY NOTES).
- 2. EXTERIOR WALLS SHALL BE 8" THK. BLK. WITH VERTICAL REINFORCEMENT 3/8" PIA. BARS AT 32" O.C. AND 3/8" PIA HORIZONTAL BARS AT 48" O.C. GROLIT CELLS (SEE KEY NOTES
- 3. INTERIOR MASONRY WALLS SHALL BE 4" OR 6" THK. BLK. AS SHOWN ON PLAN W/ 3/8" PIA. VERT'L. REBARS AT 32" $\it O.C.$ AND 3/8" PIA HORIZONTAL BARS AT 48" O.C. GROUT CELLS (SEE KEY NOTES).
- 4. SPECIFIED COMPRESSIVE STRENGTH OF MASONRY AT THE AGE OF 28 PAYS
- 5. MANUFACTURER OF MASONRY UNITS SHALL SUBMIT TO THE ENGINEER A CERTIFICATE CERTIFYING THE COMPRESSIVE STRENGTH OF MASOURY BLOCKS
- 6. A MINIMUM OF 1/2" DIA. REBAR SHALL BE PLACED AT OPENINGS IN WALL SEE TYPICAL DOOR & WINDOW OPENING DETAILS ON SHEET 5-08.

EVALUATION OF CONCRETE

- I. THE CONTRACTOR SHALL ALLOW IN HIS RATES FOR CLIRING AND TESTING OF CONCRETE SPECIMENS FOR THE FOLLWING ITEMS:
- A. FOUNDATION
- B. CONCRETE SLAB
- CONCRETE COLIMINS D. CONCRETE BEAMS

TEST RESULT SHALL BE FURNISHED TO THE STRUCTURAL ENGINEER FOR APPROVAL.

- 2. A MINIMUM OF FOUR SPECIMENS SHALL BE CURED AND TESTED BY AN INDEPENDENT MATERIAL TESTING LABORATORY.
- 3. TWO SPECIMEN SHALL BE TESTED AT SEVEN DAYS, AND TWO AT 28 DAYS. MATERIAL TESTING LABORATORY.
- 4. A STRENGTH TEST SHALL BE THE AVERAGE OF THE STRENGTHS OF TWO CYLINDERS MADE FROM THE SAME SAMPLE OF CONCRETE.

5. THE REQUIRED AVERAGE STRENGTH SHALL EXCEED \ A	AS FOLLOWS:

\ = 3000 4000 \ = 35*00* 4500

SHOULD ANY INDIVIDUAL STRENGTH TEST RESULT FALLS BELOW THE SPECIFIED BY MORE THAN 500 PSI, WILL BE CALISE FOR REJECTION OF CONCRETE AT THE CONTRACTORS EXPENSE.



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Job Title

Proposed Residence

10.5 mls. Mollejon Road, Better in Belize, Cayo District, Belize, C.A.

Drawing Name

STRUCTURAL GENERAL NOTES & DETAILS

Drawn by Date F. Canto Tech Nov., 2018 Checked by Date

oject Number	Sheet No.


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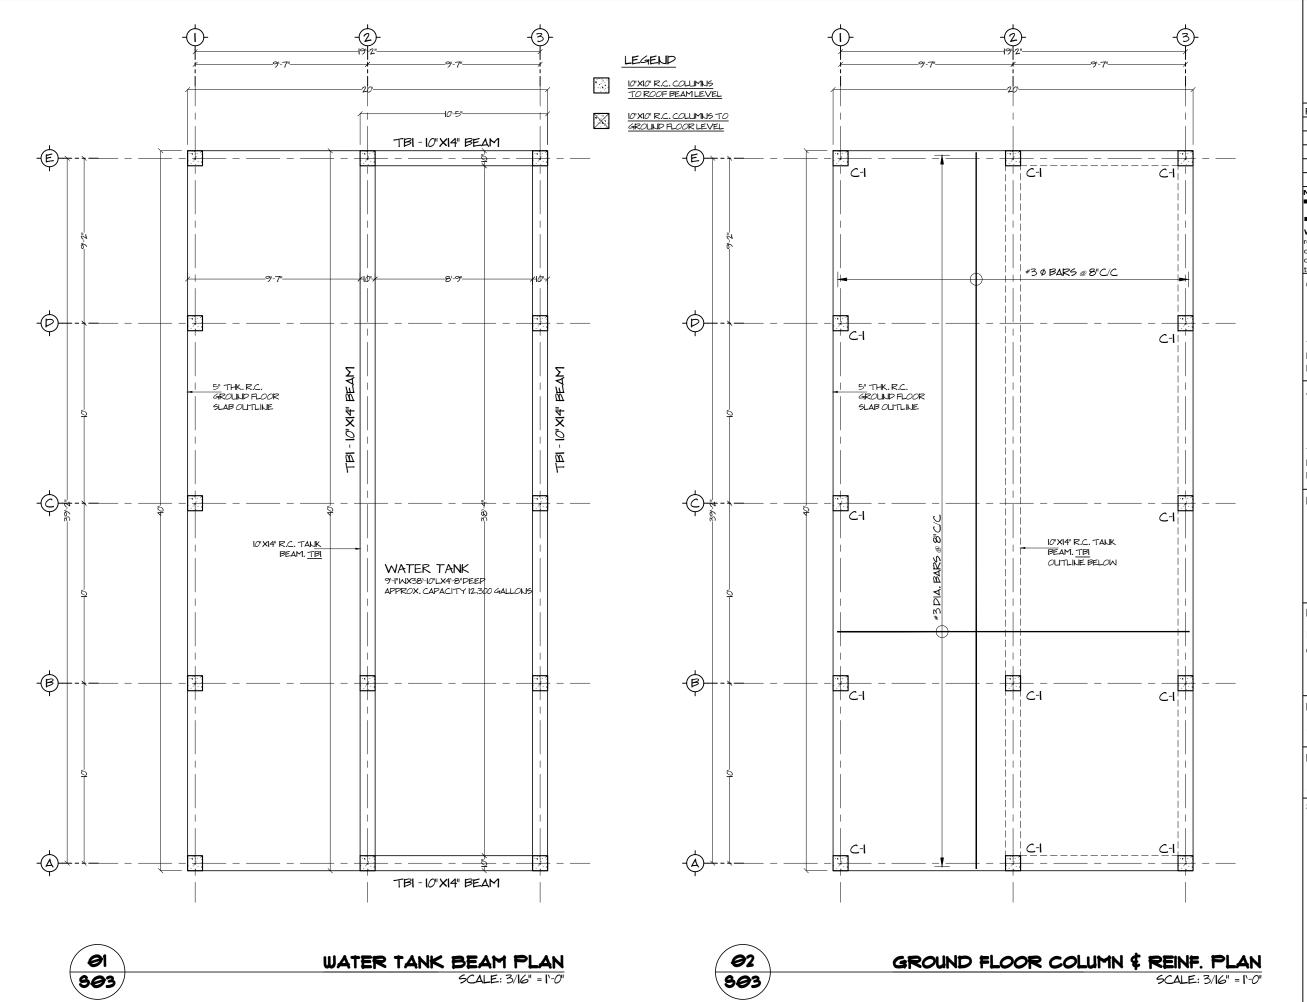
Drawing Scale

Stamps & Seals

As Shown





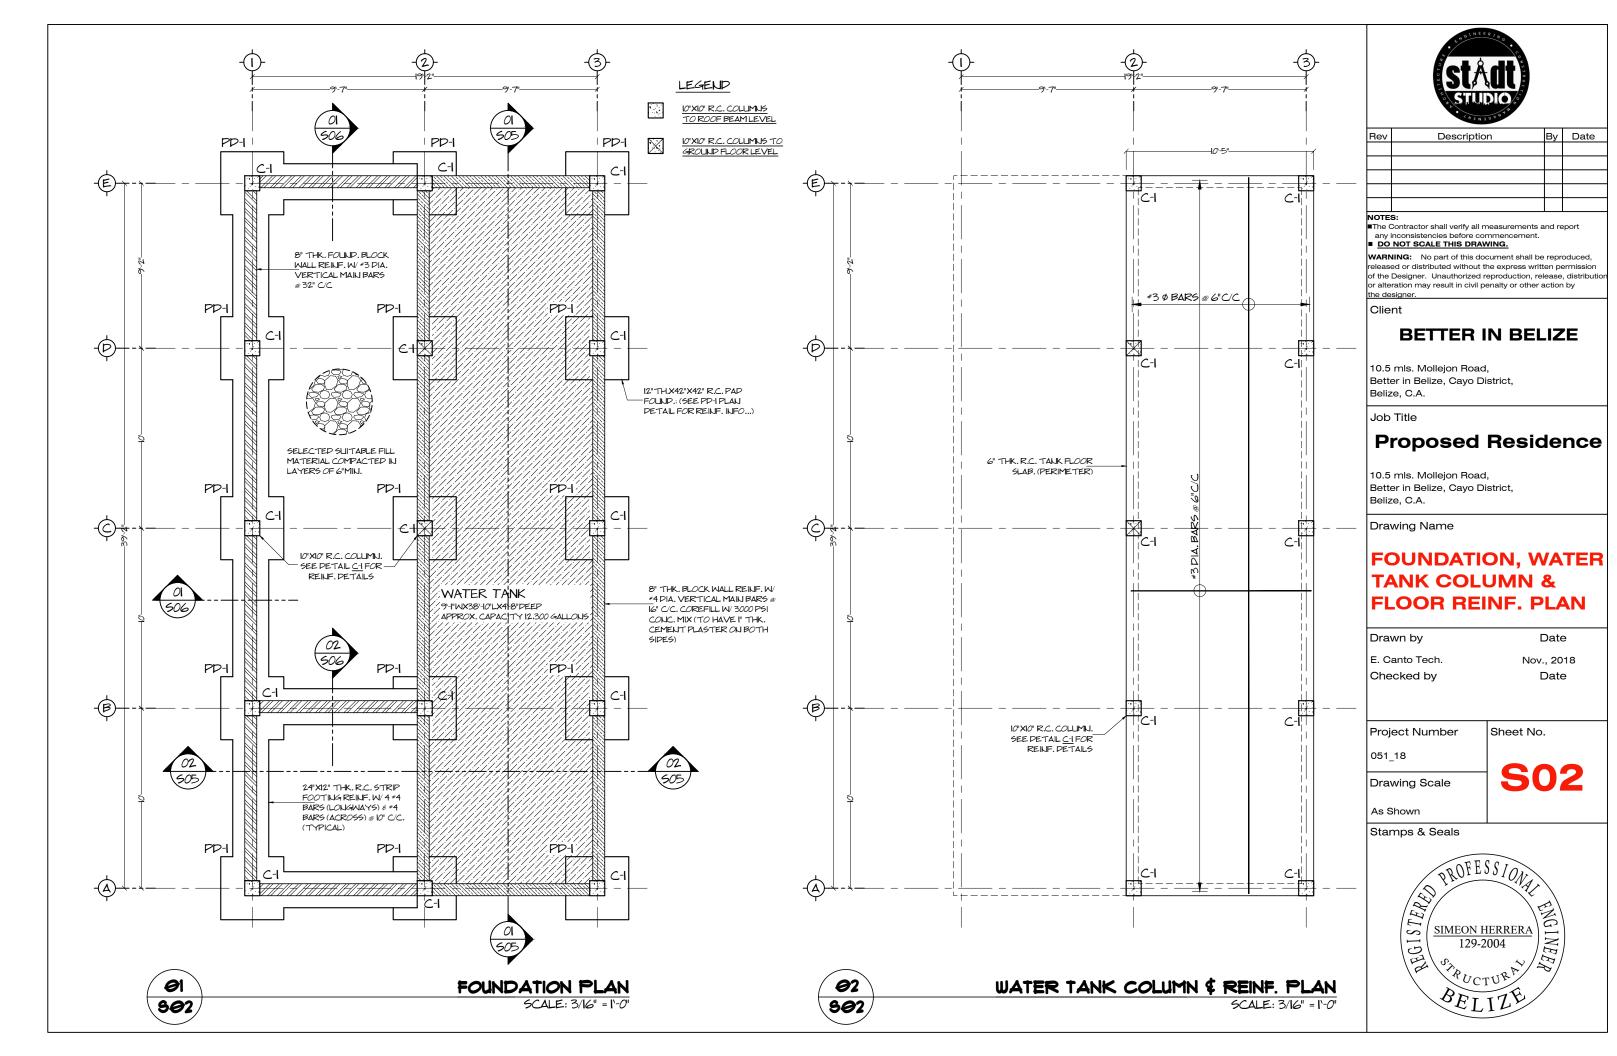



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Drawing Name

WATER TANK BEAM & GROUND FLOOR COLUMN & REINF. PLAN

Drawn by Date

E. Canto Tech. Nov., 2018

Checked by Date

Project Number


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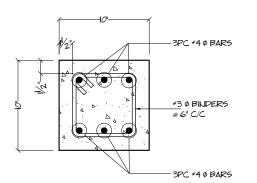
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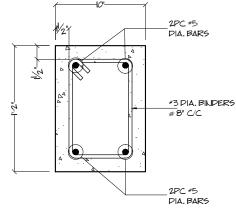
Drawing Scale S03

As Shown







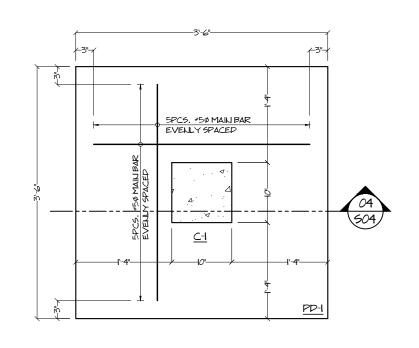



*9*3 304 SECTION

R.C. TANK BEAM -TBI 10"X14" SCALE: | |/4" = |'-0"

*30 BINDERS

R.C. COLLIMN: *40 MAIN BAR W/

*30 BINDERS @ 6" C/C.

5" R.C. FLOOR SLAB W

*30 MAIN BARS @ 10" C/C

*30 MAIN BAR @ 8" C/C B.W.

R.C. BEAM: *50 MAIN BAR W/

R.C. COLUMN: #40 MAIN BAR

W/ #30 BINDERS @ 6" C/C


*30 BINDERS @ 6" C/C

*30 BINDERS @ 6" C/C


. TOP & BOTTOM BAR (TB & BB)

@ 6" C/C

PAD FOOTING PD-1 904 PLAN VIEW SCALE: 3/4" = 1'-0"

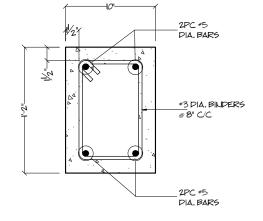



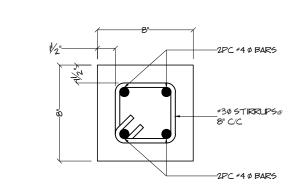



97 304

COLUMN CONNECTION DETAIL SCALE: N.T.S.

*3 DIA. BINDERS

BETTER IN BELIZE

Description

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Job Title

the designer.

Proposed Residence

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Drawing Name

FOUNDATION, BEAM **& COLUMN DETAILS**

Drawn by Date E. Canto Tech. Nov., 2018 Checked by Date

Project Number Sheet No.


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Drawing Scale


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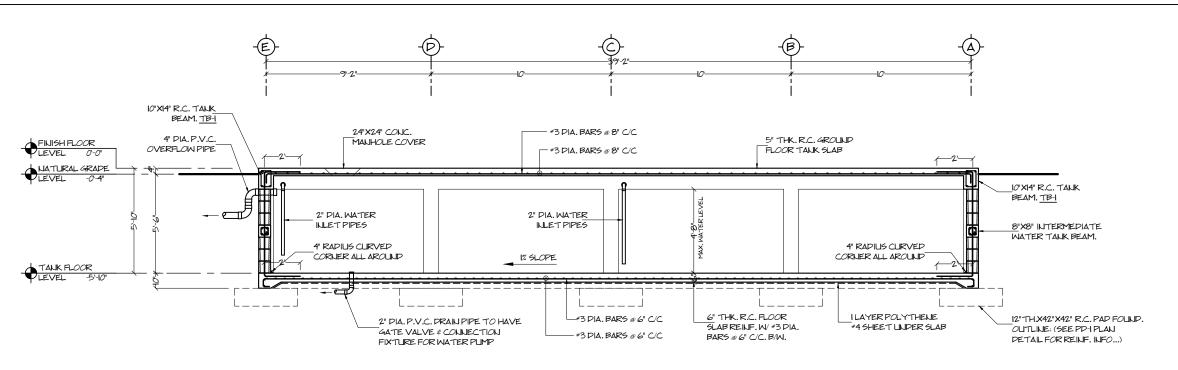
As Shown







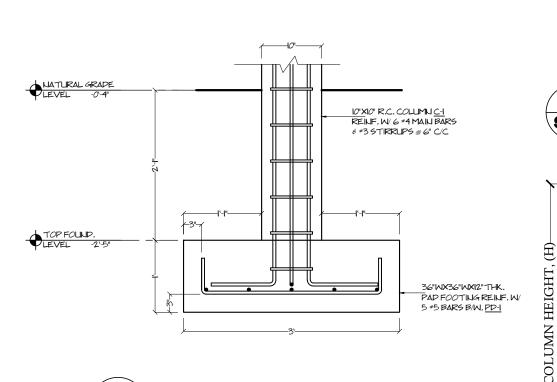


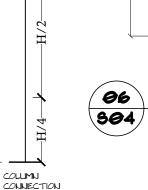



WATER TANK SECTION

SCALE: 3/16" = 1'-0'

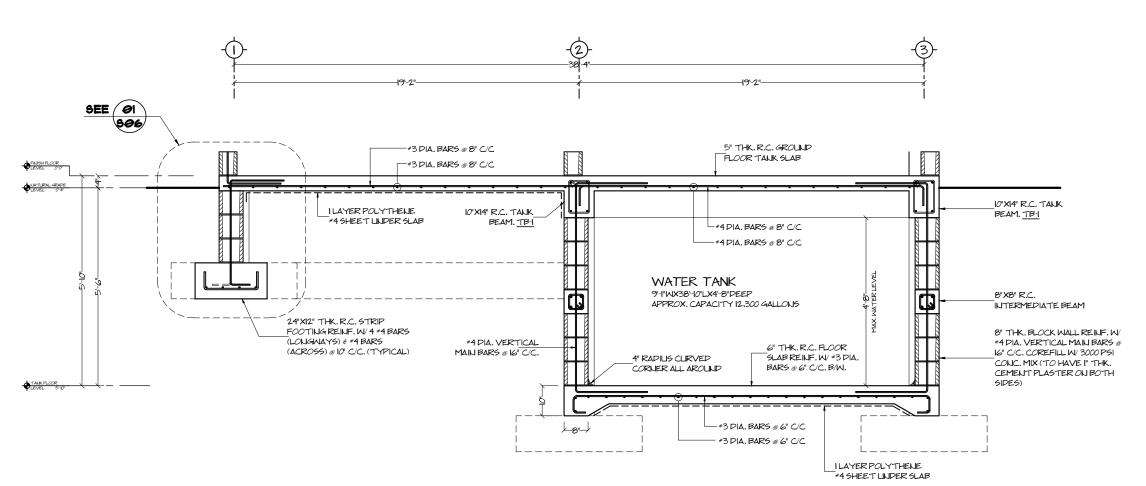



WATER TANK SECTION

SCALE: 3/8" = 1'-0"



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Drawing Name

WATER TANK SECTIONS

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Project Number


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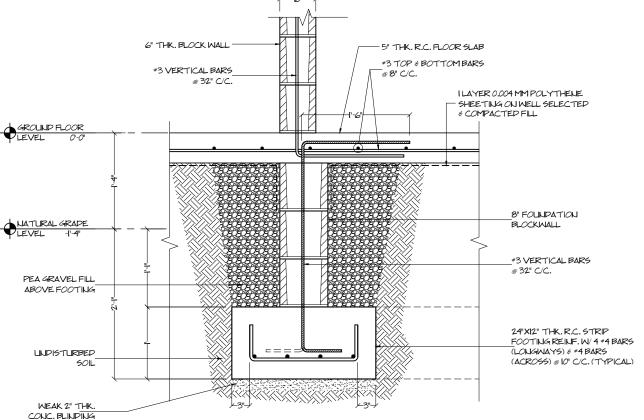
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051_18

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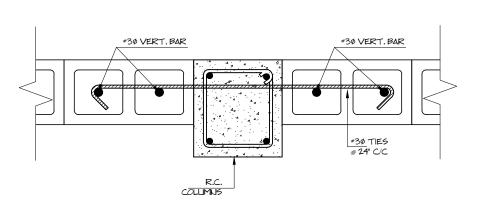








SECTION DETAIL - STRIP
FOOTING (PERIMETER)
SOB

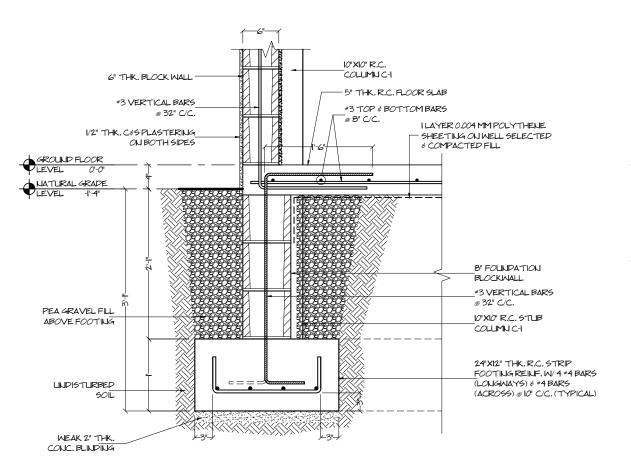9ECTION DETAIL - STRIP FOOTING (INTERMEDIATE) SCALE: 3/4" = 1/0"



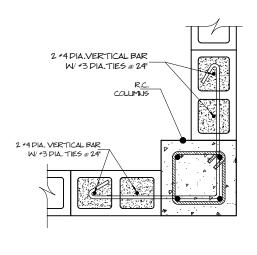

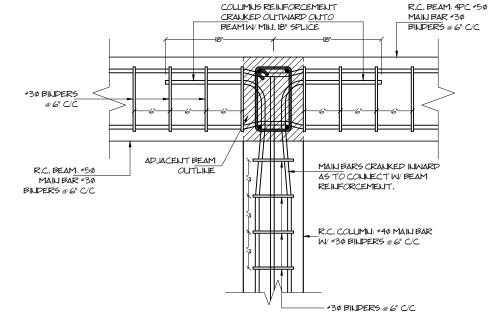

996

WALL & COLUMN DETAIL
SCALE: N.T.S.



BLOCK/ COLUMN
WALL CORNER DETAIL
SCALE: N.T.S.



COLUMN END DETAILSCALE: N.T.S.



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Drawing Name

FOOTING & COLUMN CONNECTION DETAILS

Drawn by Date

E. Canto Tech. Nov., 2018

Checked by Date

Project Number

051_18

Drawing Scale

S06

Sheet No.


As Shown



NOTE:

THESE PIAGRAM ARE SCHEMATIC. THEY ARE <u>NOT</u> INTENDED TO SHOW THE NUMBER OF BLOCK ROWS FOR THE WALL. FOR TOTAL HEIGHT OF WALLS PLEASE REFER TO ARCHITECTURAL


TYPICAL DOOR OPENING 507 SCALE: N.T.S.

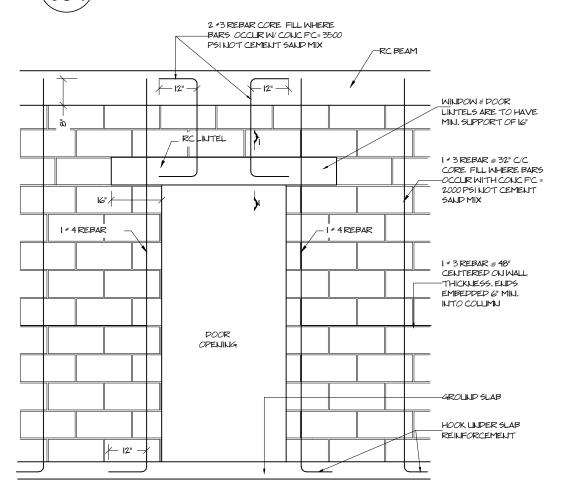

NOTE:

- CORE WITH REINFORCEMENT TO BE FILLED WITH 3500 PSI
- CONCRETE
- -ALL CONCRETE MASONRY LINITS SHALL HAVE AT LEAST 700 PSI (GROSS) MIN. COMPRESSIVE STRENGTHAT 28 DAYS.

02 TYPICAL WINDOW OPENING SCALE: N.T.S. 507

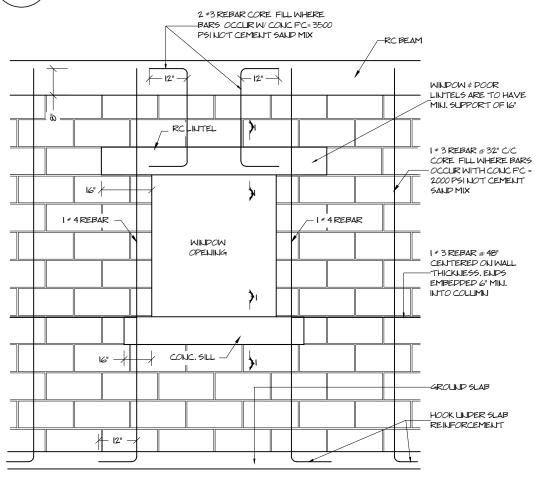



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Proposed Residence

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WALL, SILL, LINTEL & BEAM DETAILS

Drawn by Date E. Canto Tech. Nov., 2018 Checked by Date

Project Number

Sheet No.


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Drawing Scale

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Stamps & Seals






03

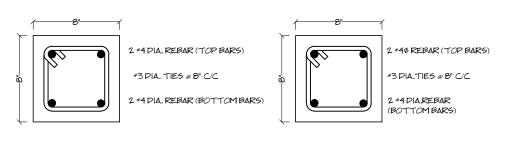507



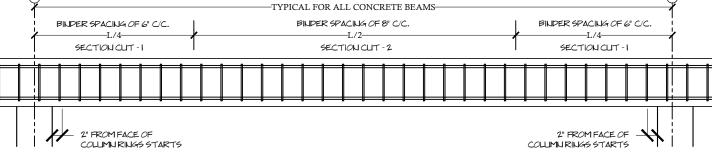


LINTEL \$ SILL SECTIONS

TYPICAL BEAM SECTION

ELECTRICAL LEGEND

EVAPORATOR SPLIT LINIT

DESCRIPTION	SYMBOL	PESCRIPTION	SYMBOL	DESCRIPTION
120 V FLUSH 3-PIN OUTLET 16" OFF FINISHED GROUND LEVEL.	Ф	PUSHBUTTON SWITCH (POOR BELL)	®	EMERGENCY EXIT LIGHTED SIGN
120 V FLUSH 3-PIN OUTLET UNDER BUILDING	Фи	SINGLE POLE LIGHT SWITCH	\$	MOTION SENSOR SPOTLIGHT WITH PHOTO CELL LIGHT SWITCH
COUNTER TOP OUTLET 42" ABOVE FINISHED GROUND LEVEL	Фс	POUBLE POLE LIGHT SWITCH	# ²	IX20 TUBE FLUORESCENT, I LAMP, 120V
120 V FLUSH 3-PIN OUTLET @ FINISHED FLOOR LEVEL.	Ф	3MAY LIGHT SWITCH	# ³	2X40 TUBE FLUORESCENT, I LAMP, 120V
120 V FLUSH 3-PIN OUTLET @ CEILING LEVEL FOR GARAGE DOOR MECHANISM.	Фа	4WAY LIGHT SWITCH	#^4	LOW PROFILE WRAPAROLIND FLUORESCENT LAMP, 2 LAMP, 2X20
GFCI FLUSH OUTLET WITH WEATHER PROOF COVER PLATES.	Ø _{NP}	FLUORESCENT CEILING LIGHT FIXTURE	\oplus	LOW PROFILE WRAPAROLIND FLUORESCENT LAMP, 2 LAMP, 2X40
240 V FLUSH OUTLET 42" OFF FINISHED GROUND LEVEL.	240V	4" RECESS LIGHTING	⊕	EXTRACTOR FAN / EXHAUST FAN
CABLE TELEVISION TERMINAL POINT	[C]	6" HANGING CEILING LIGHT FIXTURE	\bigoplus	
TELEPHONE TERMINAL POINT.	₹	INTERNAL WALL HUNG LIGHT FIXTURE (SCONCE)	立	CHANDELIER LIGHT FIXTURE
ETHERNET TERMINAL POINT.	₹	EXTERNAL WALL HUNG LIGHT FIXTURE	•	PREMIUM TROFFER 25P SERIES, 24"X24"
GROUND FAULT CIRCUIT INTERRUPTER	<u>GFCI</u>	VANITY WALL HUNG LIGHT FIXTURES REFLECTING ON CEILING	<u> </u>	
PHOTO CELL LIGHT SWITCH	P	VANITY TRACK LIGHTS	• • •	
CLASS A FIRE EXTINGUISHER (28 LBS.)	O A			DECORATIVE CEILING FAN COMPLETE W/LIGHTS
ADDRESSABLE SMOKE DETECTOR	Ø			
DISTRIBUTION PANEL (RECESSED)		<u></u>	•	•
CONDENSING SPLIT UNIT	A/C			

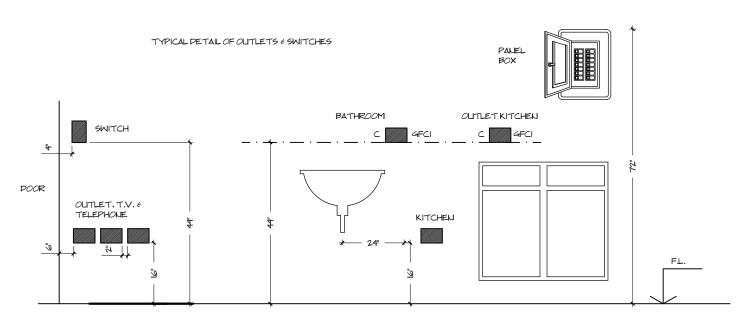

NOTE: ALL SWITCHES AND OLITLETS TO BE AT LEAST 4" AWAY FROM DOOR OR WINDOWS OPENING

12-K



GENERAL ELECTRICAL NOTES

SYMBOL

- I.) ALL WORKS SHALL BE DONE IN ACCORDANCE WITH LOCAL APPLICABLE CODE.
- 2.) THE PRAWINGS ARE PIAGRAMMATIC AND DO NOT SHOW ALL OFFSETS, BENDS AND BOXES REQUIRED TO MAKE A COMPLETE NEAT INSTALLATION IN ACCORDANCE WITH APPLICABLE COPE.
- 3.) APPROVAL SHALL BE OBTAINED FROM STRUCTURAL ENGINEER PRIOR TO CLITTING OR DRILLING ANY STRUCTURAL SUPPORT MEMBER.
- 4.) WIRE SIZES SHALL BE *12 THIN/THINN UNLESS OTHERWISE NOTED ON PLANS. CONDUCTOR *6 OR LARGER SHALL BE THINN.
- 5.) ALL CONDUCTORS TO BE COPPER LINLESS OTHERWISE NOTED
- 6.) ALL COUDLICTORS SHALL BE RUN IN CONPUIT. (NON-METALLIC TYPE) NMC CABLE IS PERMITTED AS AN OPTION. IF PVC SCHEDULE 40 IS USED FOR UNDERGROUND FEEDERS ONLY, AN EQUIPMENT GROUND CONDUCTOR MUST BE INSTALLED AND CONDUIT SIZE INCREASE AS REQUIRED. THE USE OF NMC IS PERMITTED FOR ALL OTHER WIRING.
- 7.) ALL NON POWER RELATED WIRING CAN BE RUN IN CEILING PLENUM WITHOUT CONDUIT
- 8.) FUSES SHALL BE DUAL ELEMENT, TIME DELAY TYPE UNLESS OTHERWISE NOTED.
- 9.) ALL LUMINARIES SHALL BE PROPERLY SUPPORTED IN ACCORDANCE WITH THE CEILING SYSTEM MANUFACTURER RECOMMENDATIONS AND LOCAL CODE REQUIREMENTS.
- IO.) THIS DRAWING IS A GUIDE FOR THE ELECTRICAL INSTALLATION OF ELECTRICAL SERVICE.

 THE ELECTRICAL CONTRACTOR IS RESPONSIBLE TO PROVIDE A FUNCTIONING SYSTEM.
- II.) ALL CABLES SHALL BE RUN WITHOUT SPLICES EXCEPT OTHERWISE INDICATED.
- 12.) ALL PULL AND JUNCTION BOXES SHALL BE ACCESSIBLE AT ALL TIMES
- 13.) EXACT POINT AND METHODS OF CONNECTION SHALL BE DETERMINED IN FIELD.
- 14.) ALL WORK SHALL BE DONE IN A NEAT AND WORKMANLIKE MANNER.
- (5.) ALL RACEMAY ROUTED, INSULATED CONDLICTORS SYSTEMS SHALL BE COLOR CODED AS FOLLOWS:

240/120V SYSTEM

PHASE 'A' BLACK PHASE B' RED PHASE 'C' BLUE NEUTRAL WHITE GROUND GREEN

- 16.) ALL ROUGH IN PIMENSIONS ARE TO CENTER LINE OF DEVICE UNLESS OTHERWISE NOTED.
- 17.) ALL CONDUCTOR SPLICES IN EXTERIOR LOCATED PLILL BOXES EXPOSED TO THE WEATHER TO BE WEATHER SEALED.
- 18.) CONTRACTOR IS ALLOWED TO REARRANGE THE DISTRIBUTION OF THE ELECTRICAL LOADS

 CONNECTED TO THE BRANCH CIRCUITS IN THE FIELD, AS LONG AS LOAD IS BALANCED \$

 INDEPENDENT CIRCUIT LOADING IS IN COMPLIANCE WITH LOCAL CODE.
- 19.) DISTRIBUTION PANELS SHALL BE NEMAI WITH PUSH-ON BREAKERS COMPLETE WITH SEPARATE NEUTRAL AND GROUND BARS AS IS EXISTING.
- 20) TELEPHONE WIRING SHOULD BE 2 RUNS OF CAT 5 NETWORK CABLING.



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Job Title

Proposed Residence

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Drawing Name

ELECTRICAL LEGEND & NOTES

Drawn by Date

E. Canto Tech. Nov., 2018

Checked by Date

Project Number


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Drawing Name

ELECTRICAL LIGHTING & POWER PLAN

Drawn by Date E. Canto Tech. Nov., 2018 Checked by Date

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PLUMBING LEGEND

SYMBOL	PESCRIPTION
711 1101	
4" ØSW	4" Ø P.V.C. SOLID WASTE PIPE (4" ØSW), FROM W.C.
4"95M	TO SEPTIC TANK
	2" \(P.V.C. LIQUIP WASTE PIPE
	(2" ØLW), FROM ALL FIXTURES
2" ØLW	TO SOAK-AWAY
	2" Ø P.V.C. VENT PIPE (2" Ø V.T.)
	FROM ALL FIXTURES TO MAIN
2441	STOCK THROUGH CEILING
CUMBO	
SYMBOL	DESCRIPTION
	3/4" Ø COLD WATER PIPE
3/4" ØCW	(3/4" ØCW), FROM WATER
	SYSTEM TO ALL FIXTURES
	1/2" Ø HOT WATER PIPE (½" ØHW),
½"ØHW	FROM HEATER TO FIXTURES THAT REQUIRE HOT WATER
	I TA I RECUIRE HU I WA IER
	WATER METER
———	GATE VALVE
	SHUT OFF VALVE
 >	CHECK VALVE
Н	ON DEMAND WATER HEATER
P	ELECTRONIC WATER PLIMP
	PRESSURE TAUK
PT	PRESSURE I ANK
LE A	PIPE CONNECTIONS GOING
up (•)	UP TO UPPER FLOOR
	PIPE CONNECTION GOING
ÞN (⊗)	POWN TO LOWER FLOOR
	FIXTURE CONNECTION TO PIPE
Θ—	FIX TURE CONNECTION TO FIRE
#	ELBOM, 90 ELM VE MUT
€ #	ELBOW: 90 FLANGE JOINT
ŧ.	ELBOW: 90 POUBLE
‡ +	FLANGE JOINT
*	FI POLITIZE FI ALLE TOUR
+	ELBOW: 135 FLANGE JOINT
	ELBOW: 135 POUBLE
" "	FLANGE JOINT
C.O.IH #	ELBOW: 135 POUBLE FLANGE
C.C.1111X	JOINT WITH CLEAN-OUT ACCESS
•	MAIN VENT

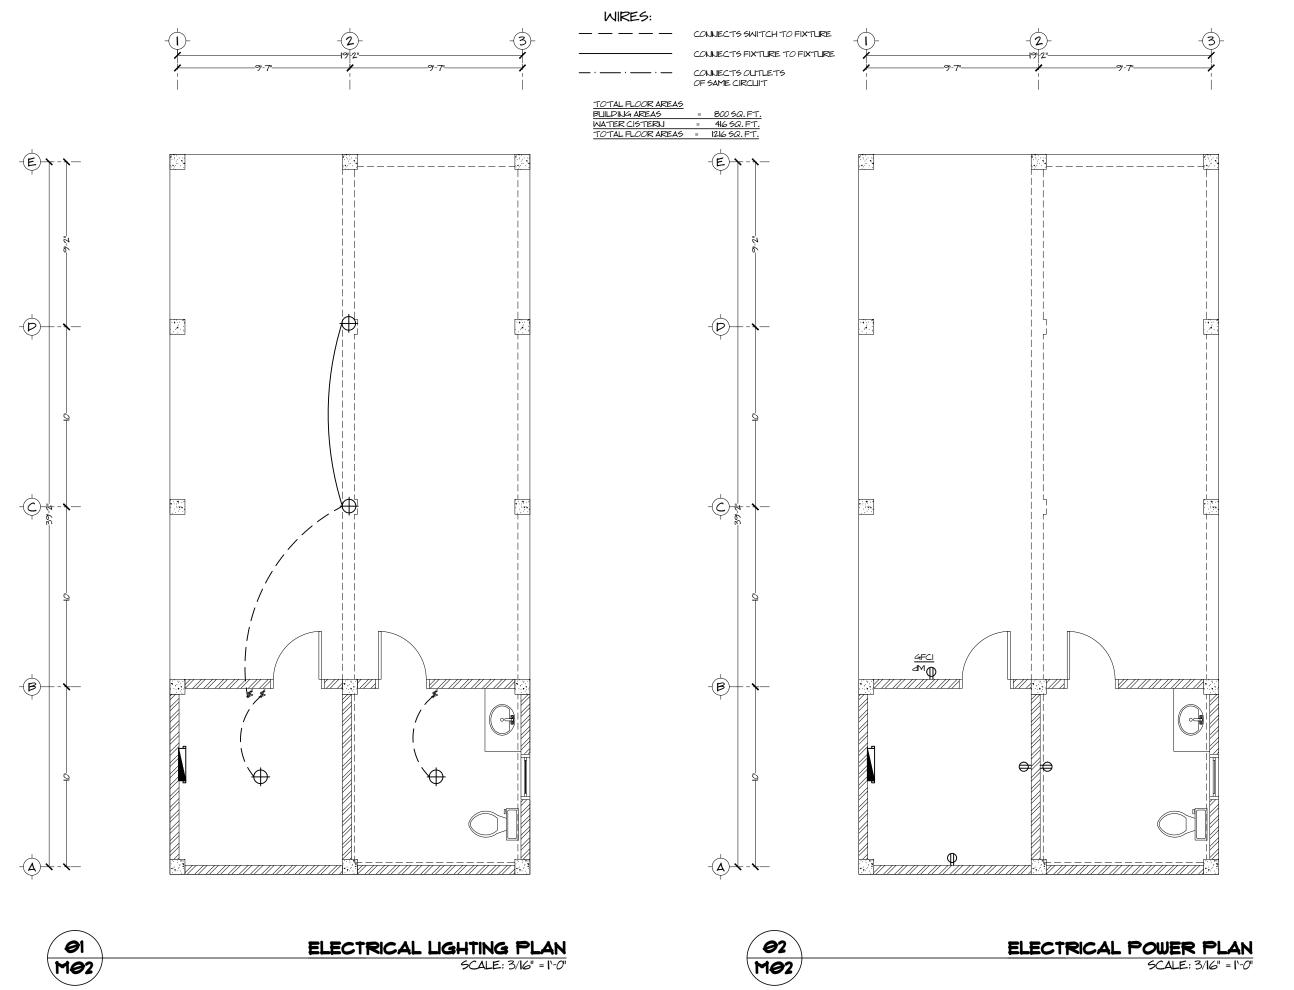

- I.- MAIN POTABLE WATER PIPE TO BE 3 OPVC SCH 40 PIPE.
- 2.-POTABLE WATER PIPE THAT LEADS TO
- ACCESSORIES TO BE 3/4" PVC SCH 40 PIPE. 3.- HOT WATER PIPE TO BE 1/2" & LIPVC SCH 40 PIPE (IF
- 4.- DISCHARGE PIPES FROM WATER CLOSETS KNOWN AS SOLID
- WASTE PIPES TO BE 4" \$ SCH 40
- 5.- DISCHARGE PIPES FROM LAVATORIES KNOWN AS LIQUID
- WASTE PIPES TO BE 2" \$ SCH 40
- 6.- ALL FITTING FOR LINES TO BE INCLUDED. VENT PIPES TO BE 2" O AND TO INCLLIDE A MAIN VENT STOCK OF 2" Ø.
- 7.- CHANGES IN DIRECTION OF SOIL/WASTE LINES TO BE
- 8.- ALL FIXTURES SHALL HAVE A 1/2" Ø ANGLE VALVE.

- 9.) ALL DRAINAGE PIPES CHANGE IN DIRECTION TO BE FITTED WITH A 135 ELBOW, EITHER SINGLE OR POLIBLE FLANGE JOINT.
- 10.) CHANGE IN PIRECTIONS SHOULD BE FITTED WITH A CLEAN OUT POINT THAT COULD BE EASILY ACCESSED & SEALED AFTER USE.
- II.) PRAINAGE SLOPE IS CALCULATED BASED ON MAGUIRE'S RULE OF THUMB, WHICH GIVES A FALL ACCORDING TO RATE OF FLOW (VELOCITY), DEPENDING ON THE DIAMETER OF THE PIPE. THE VELOCITY REQUIRED SHOULD BE AT LEAST 0.75 / (2.46 /), TO ENSURE SELF CLEANSING WITH A DRAINAGE CAPACITY OF CLEAR FLOW CONDITION.


DRAINAGE SLOPE FOR DRAINAGE PIPES 4" Ø SW PIPE: LISE A SLOPE OF I IN 40 2" Ø LW PIPE: USE A SLOPE OF I IN 20

12.) ONLY VENT PIPES CHANGE IN DIRECTION COULD BE FITTED WITH A 90 ELBOW, EITHER SINGLE OR POUBLE FLANGE JOINT.

PLAN VIEW FRONT VIEW FINISHED PLAN VIEW WALL *4"*4"* 3/4" PIA. PVC 0 WATER INLET -VALVE 0 1 FALCET PVC PIPE FRONT VIEW FRONT VIEW 3/4" Ø PVC COLD WATER 3/4" Ø PVC COLP FINISHED INLET WATER INLET 3/4" Ø CPVC HOT 3/4" CPVC HOT WALL SIDE VIEW WATER INLET WATER INLET DRAINAGE PIPE 2" Ø PVC DRAINAGE PIPE DRAINAGE PIPE

WASH HAND BASIN

SUPPLY & DRAINAGE INSTALLATION N.T.S.

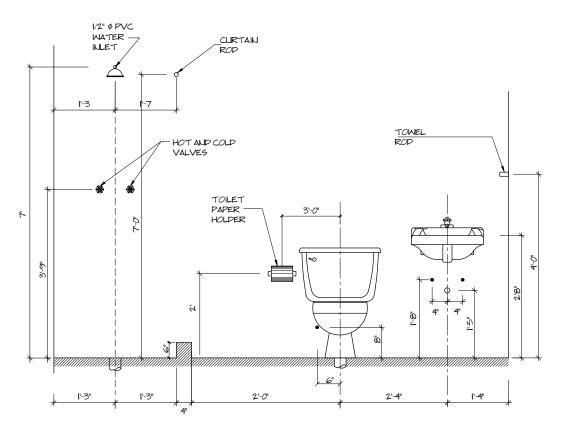

POSITION OF BATHROOM FIXTURES

ELEVATION.

KITCHEN SINK

SUPPLY & DRAINAGE INSTALLATION N.T.S.

THE DIMENSIONS SHOWN ABOVE BETWEEN FIXTURES ARE MINIMUM



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Job Title

WATER CLOSET W/ TANK

SUPPLY & DRAINAGE INSTALLATION

SCALE: N.T.S.

Proposed Residence

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PLUMBING LEGEND & NOTES

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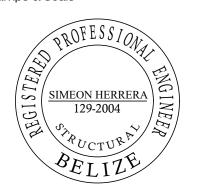
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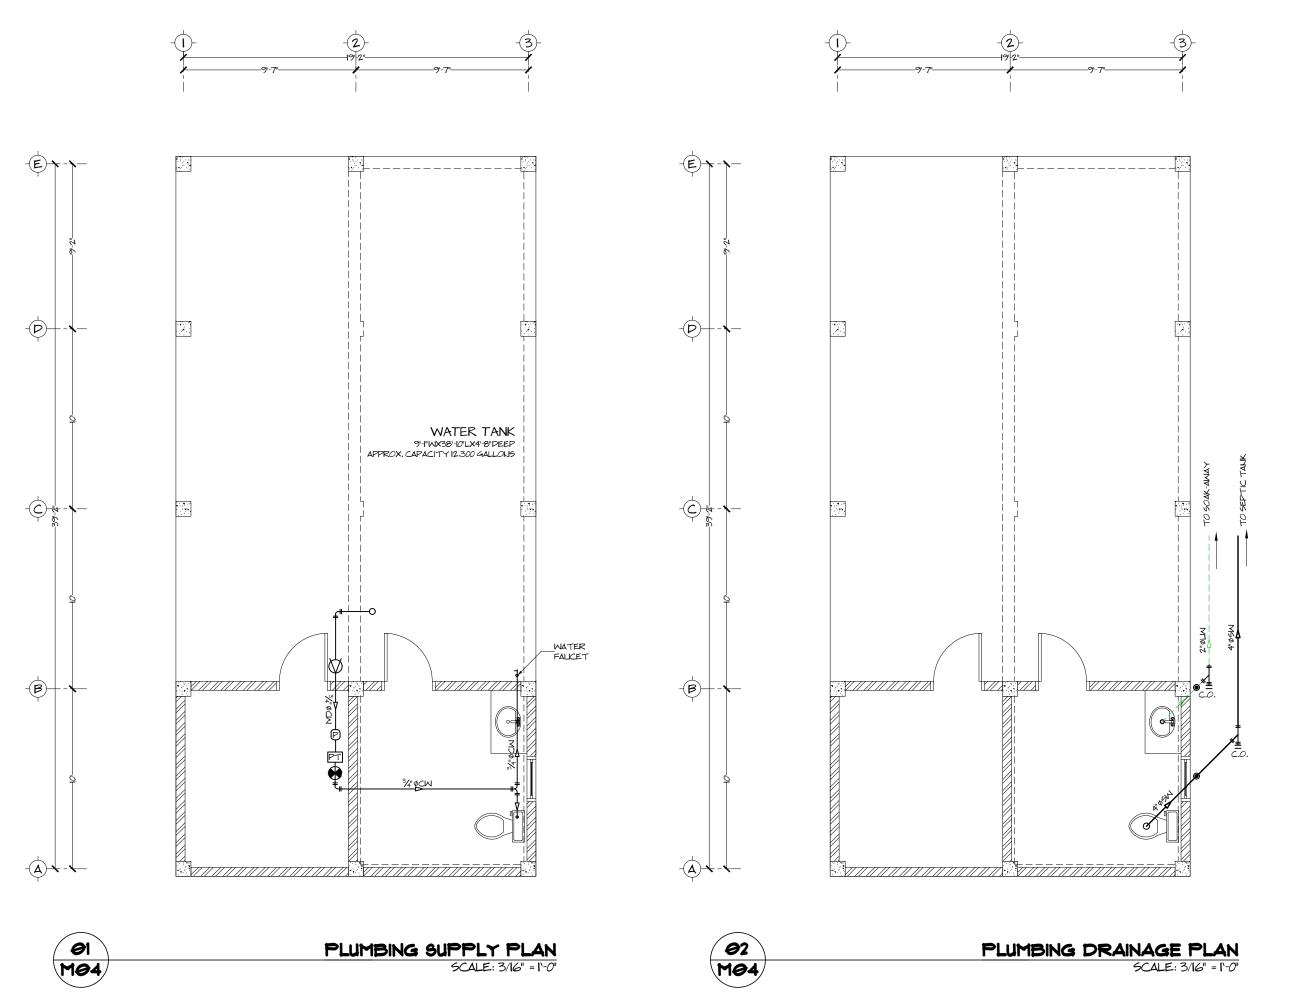
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PLUMBING SUPPLY & DRAINAGE PLAN

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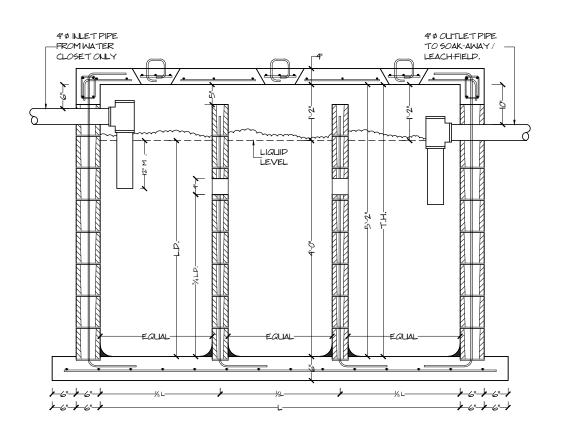
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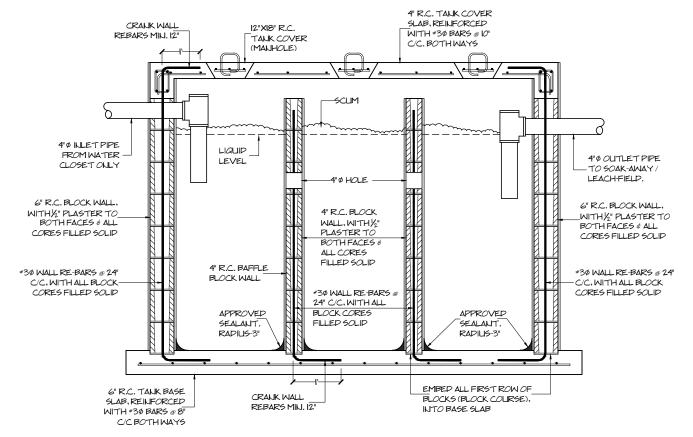
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0 SEPTIC TANK DETAIL DIMENSIONED SECTION SCALE: N.T.S. M05


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M05	

SEPTIC TANK DETAIL LABELED SECTION SCALE: N.T.S.

NUMBER OF BEDROOMS	MAXIMUM NO. OF PERSONS	NOMINAL LIQUID CAPACITY OF TANK	RECOMENDED INSIDE DIMENSIONS							
	SERVED		LENGHT WIDTH		LIQUIDI	DEPTH	TOTAL HEIGHT			
NUMBER	PERSONS	LIS GALLONS (APPROX)	FT	И	FT	IN	FT	IN	FT	М
2	6	600	7	0	3	0	4	0	5	2

SPECIFICATIONS:

- I. INLET PIPE MUST DIP 12" BELOW LIQUID LEVEL IN TANK.
- 2. TANK MUST BE AIR AND WATER TIGHT.
- 3. INVERT LEVEL OF OUTLET PIPE MUST BE 2" MINIMUM BELOW TOP OF BAFFLE WALL.

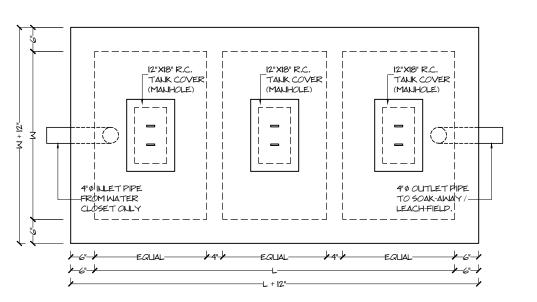



SEPTIC TANK DETAIL

LABELED PLAN VIEW SCALE: N.T.S.



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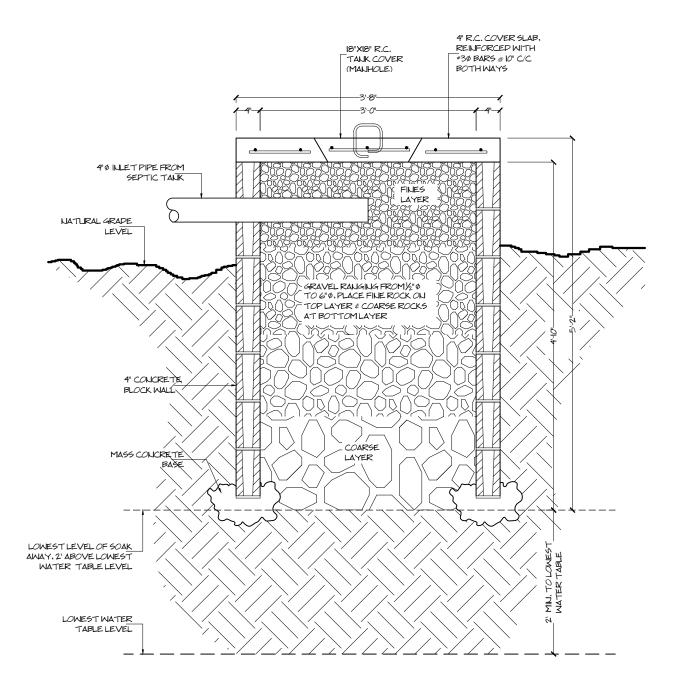
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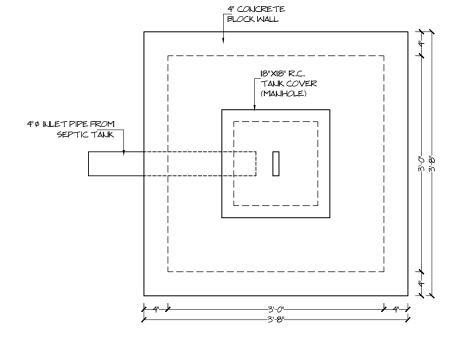
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SOAK-AWAY DETAILS

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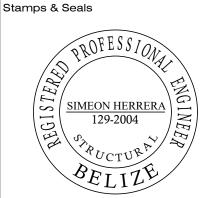
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SOAK-AWAY DETAIL

SECTION THRU

SCALE: N.T.S.